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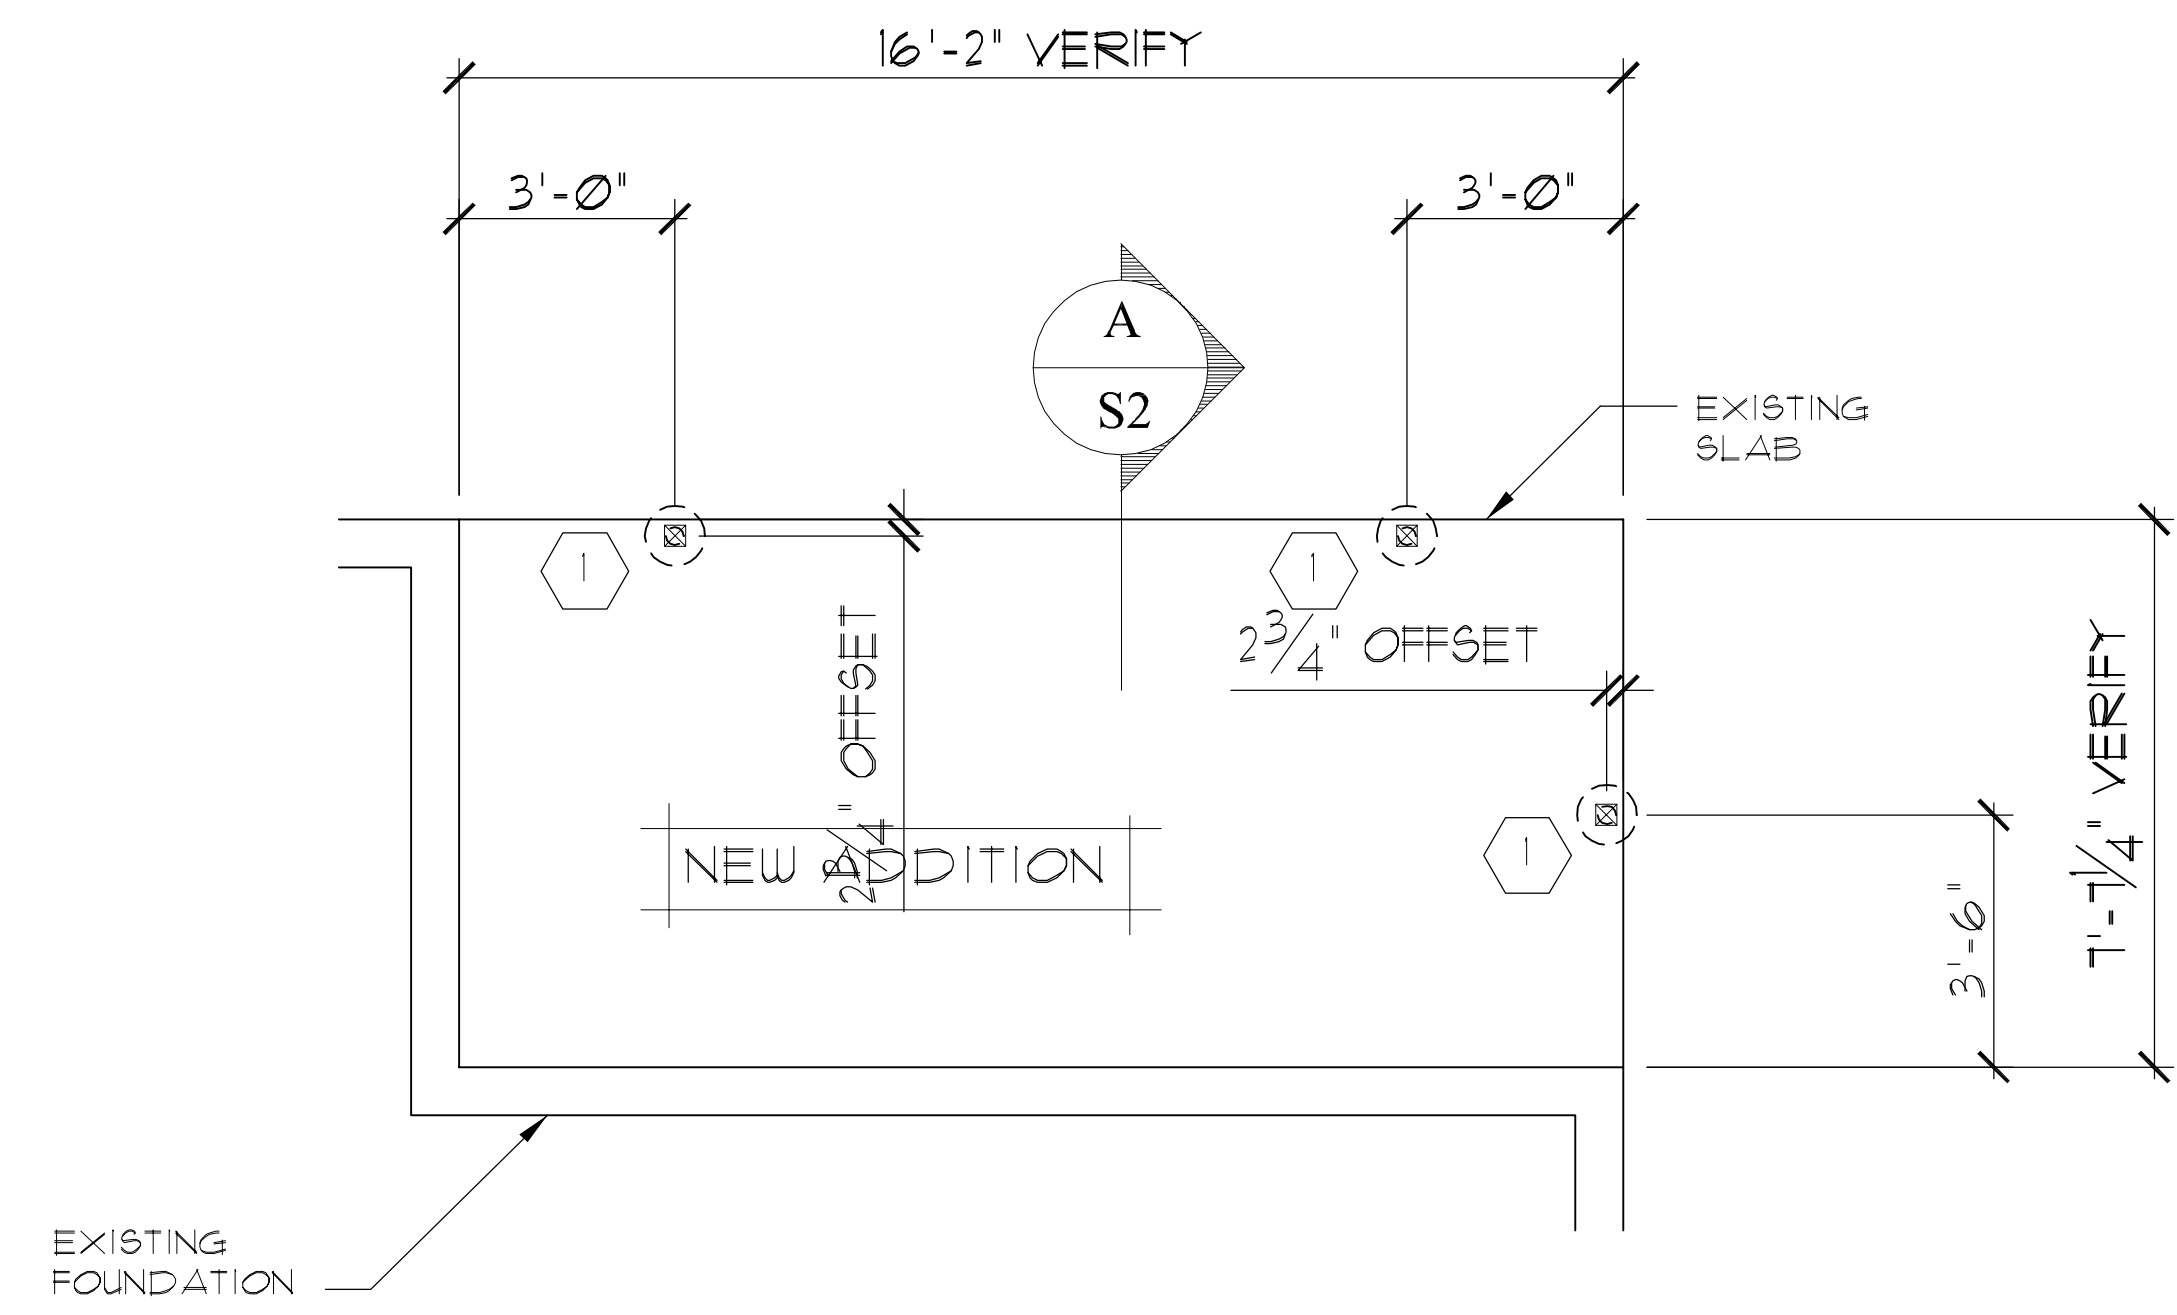
PLAN NOT VALID WITHOUT ORIGINAL WET STAMP

PROJECT NAME:


PROJECT NAME

PROJECT DESCRIPTION
STREET ADDRESS
CITY, STATE


CLIENT:
YOUR COMPANY NAME
STREET ADDRESS
CITY, STATE
Contact: Your Name
Your Number



FOUNDATION PLAN
SCALE 1/4" = 1'-0"

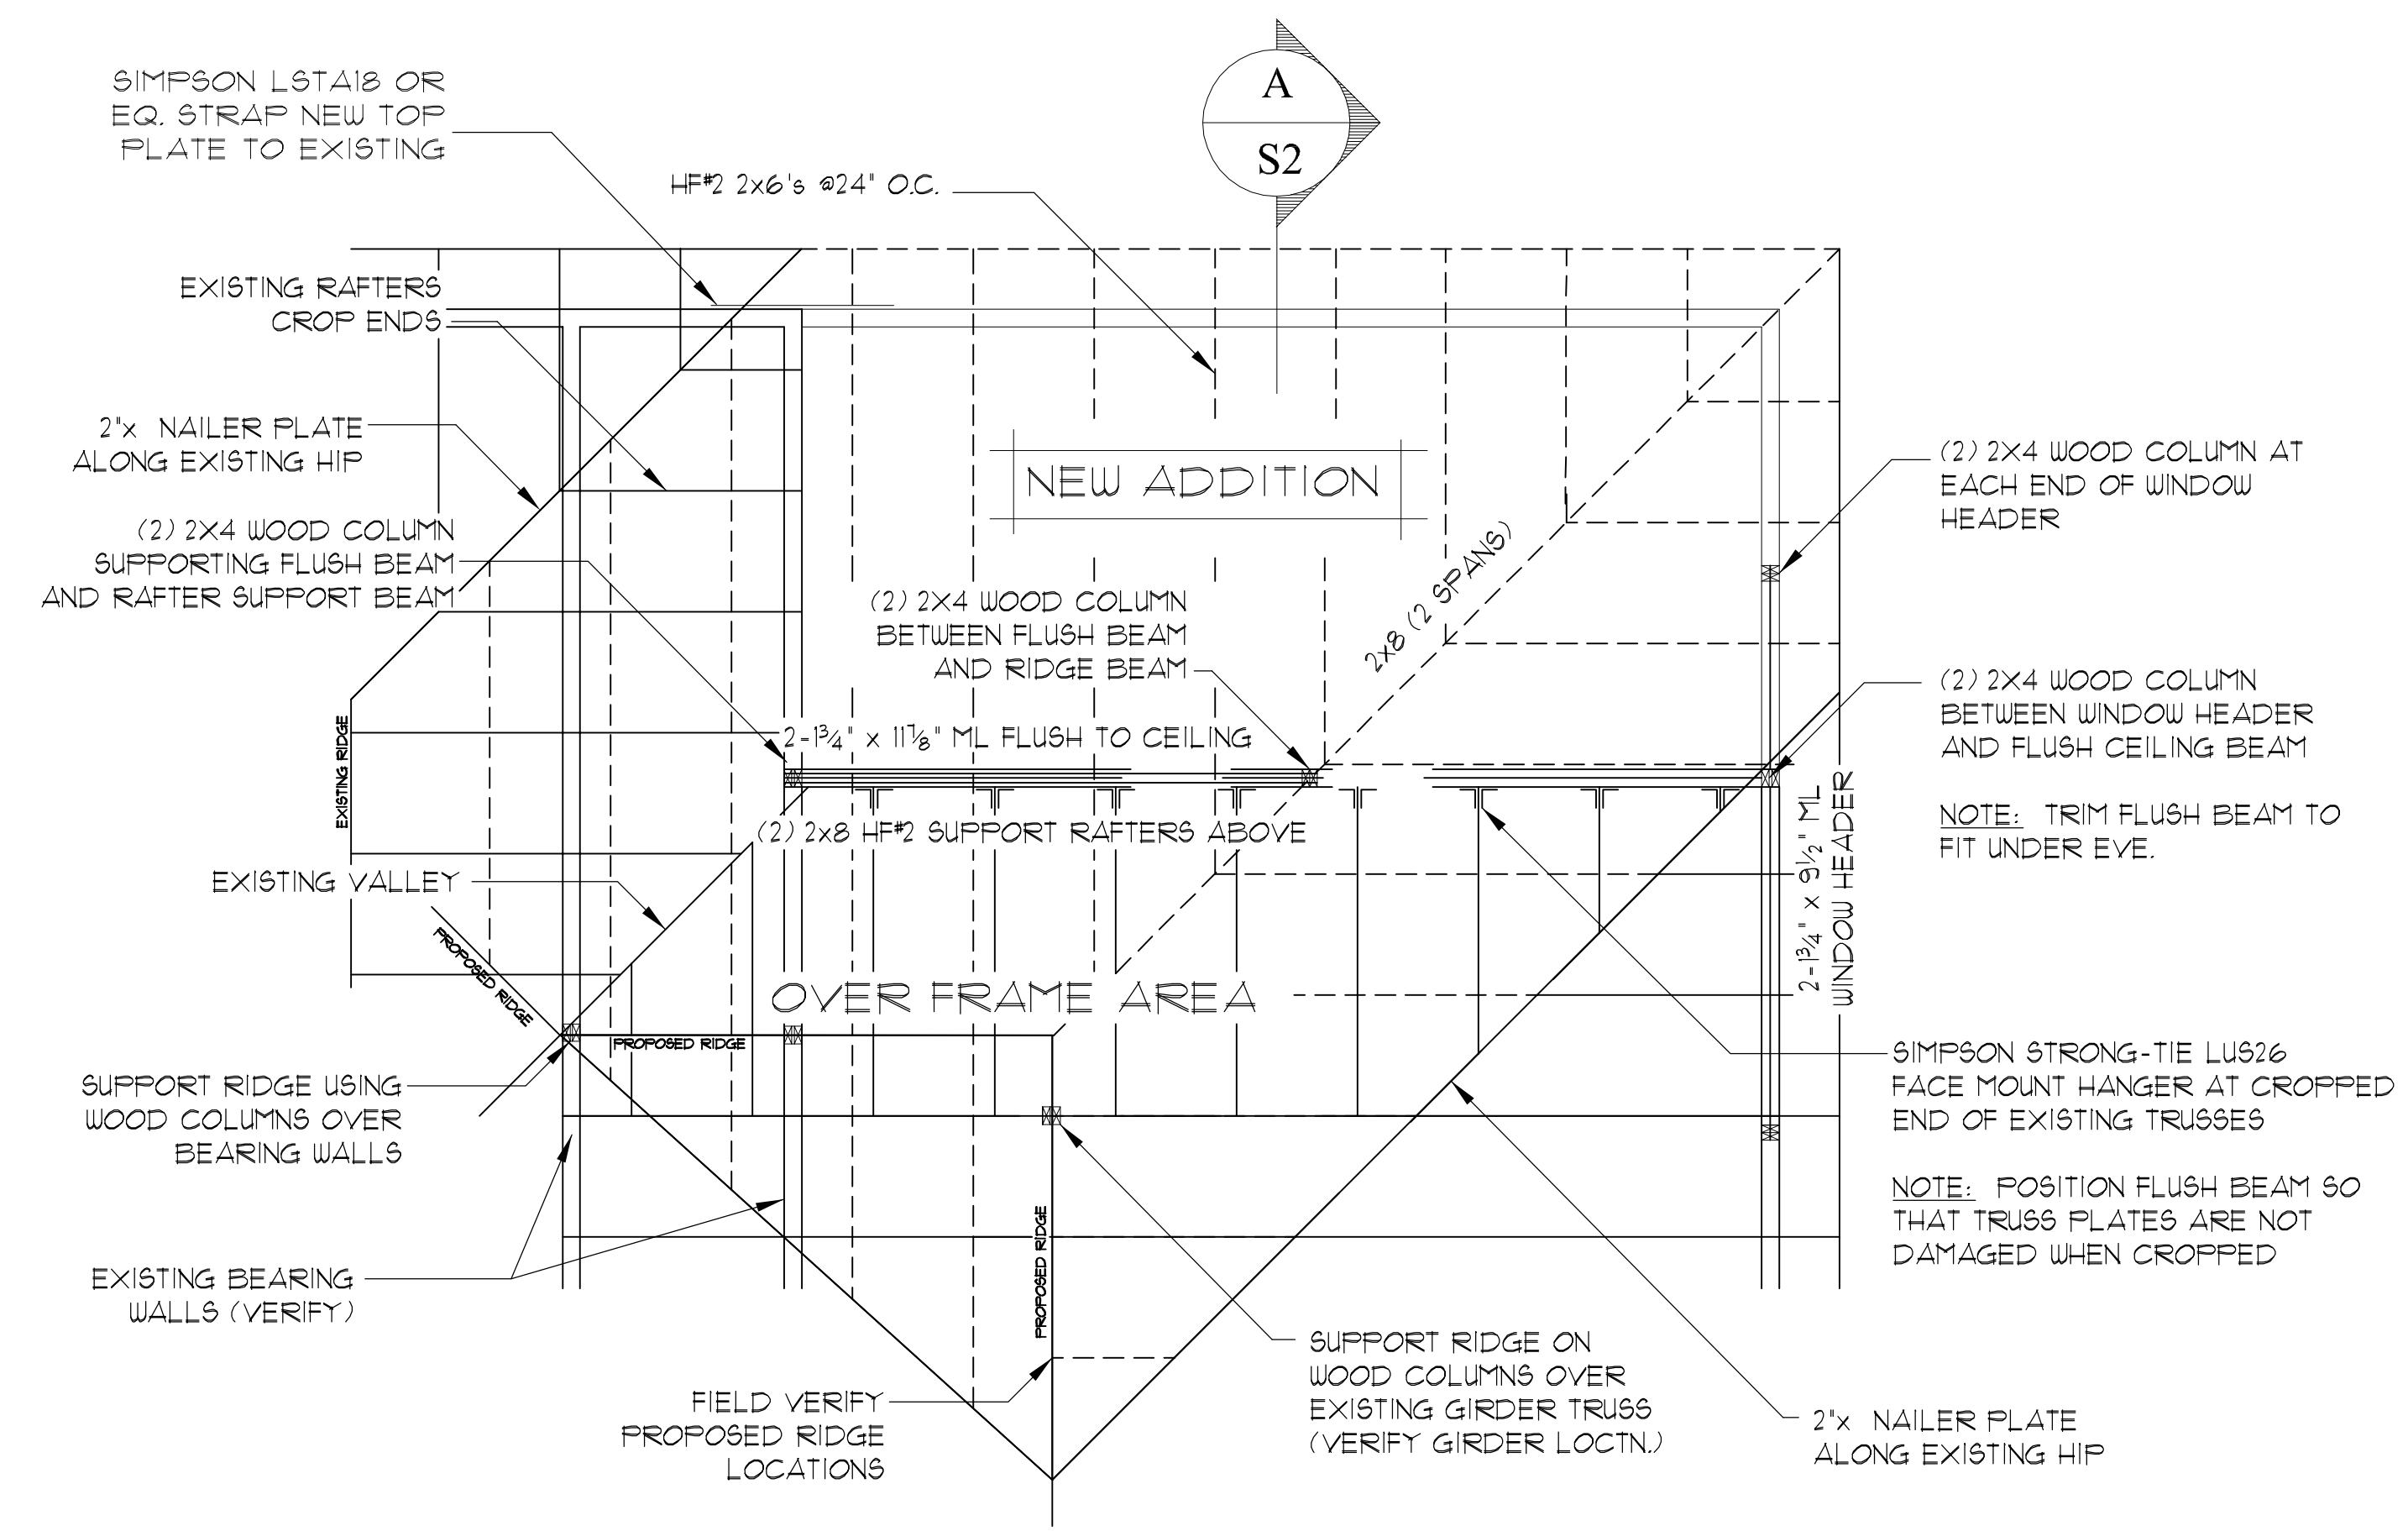

ROOF FRAMING PLAN
SCALE 1/4" = 1'-0"

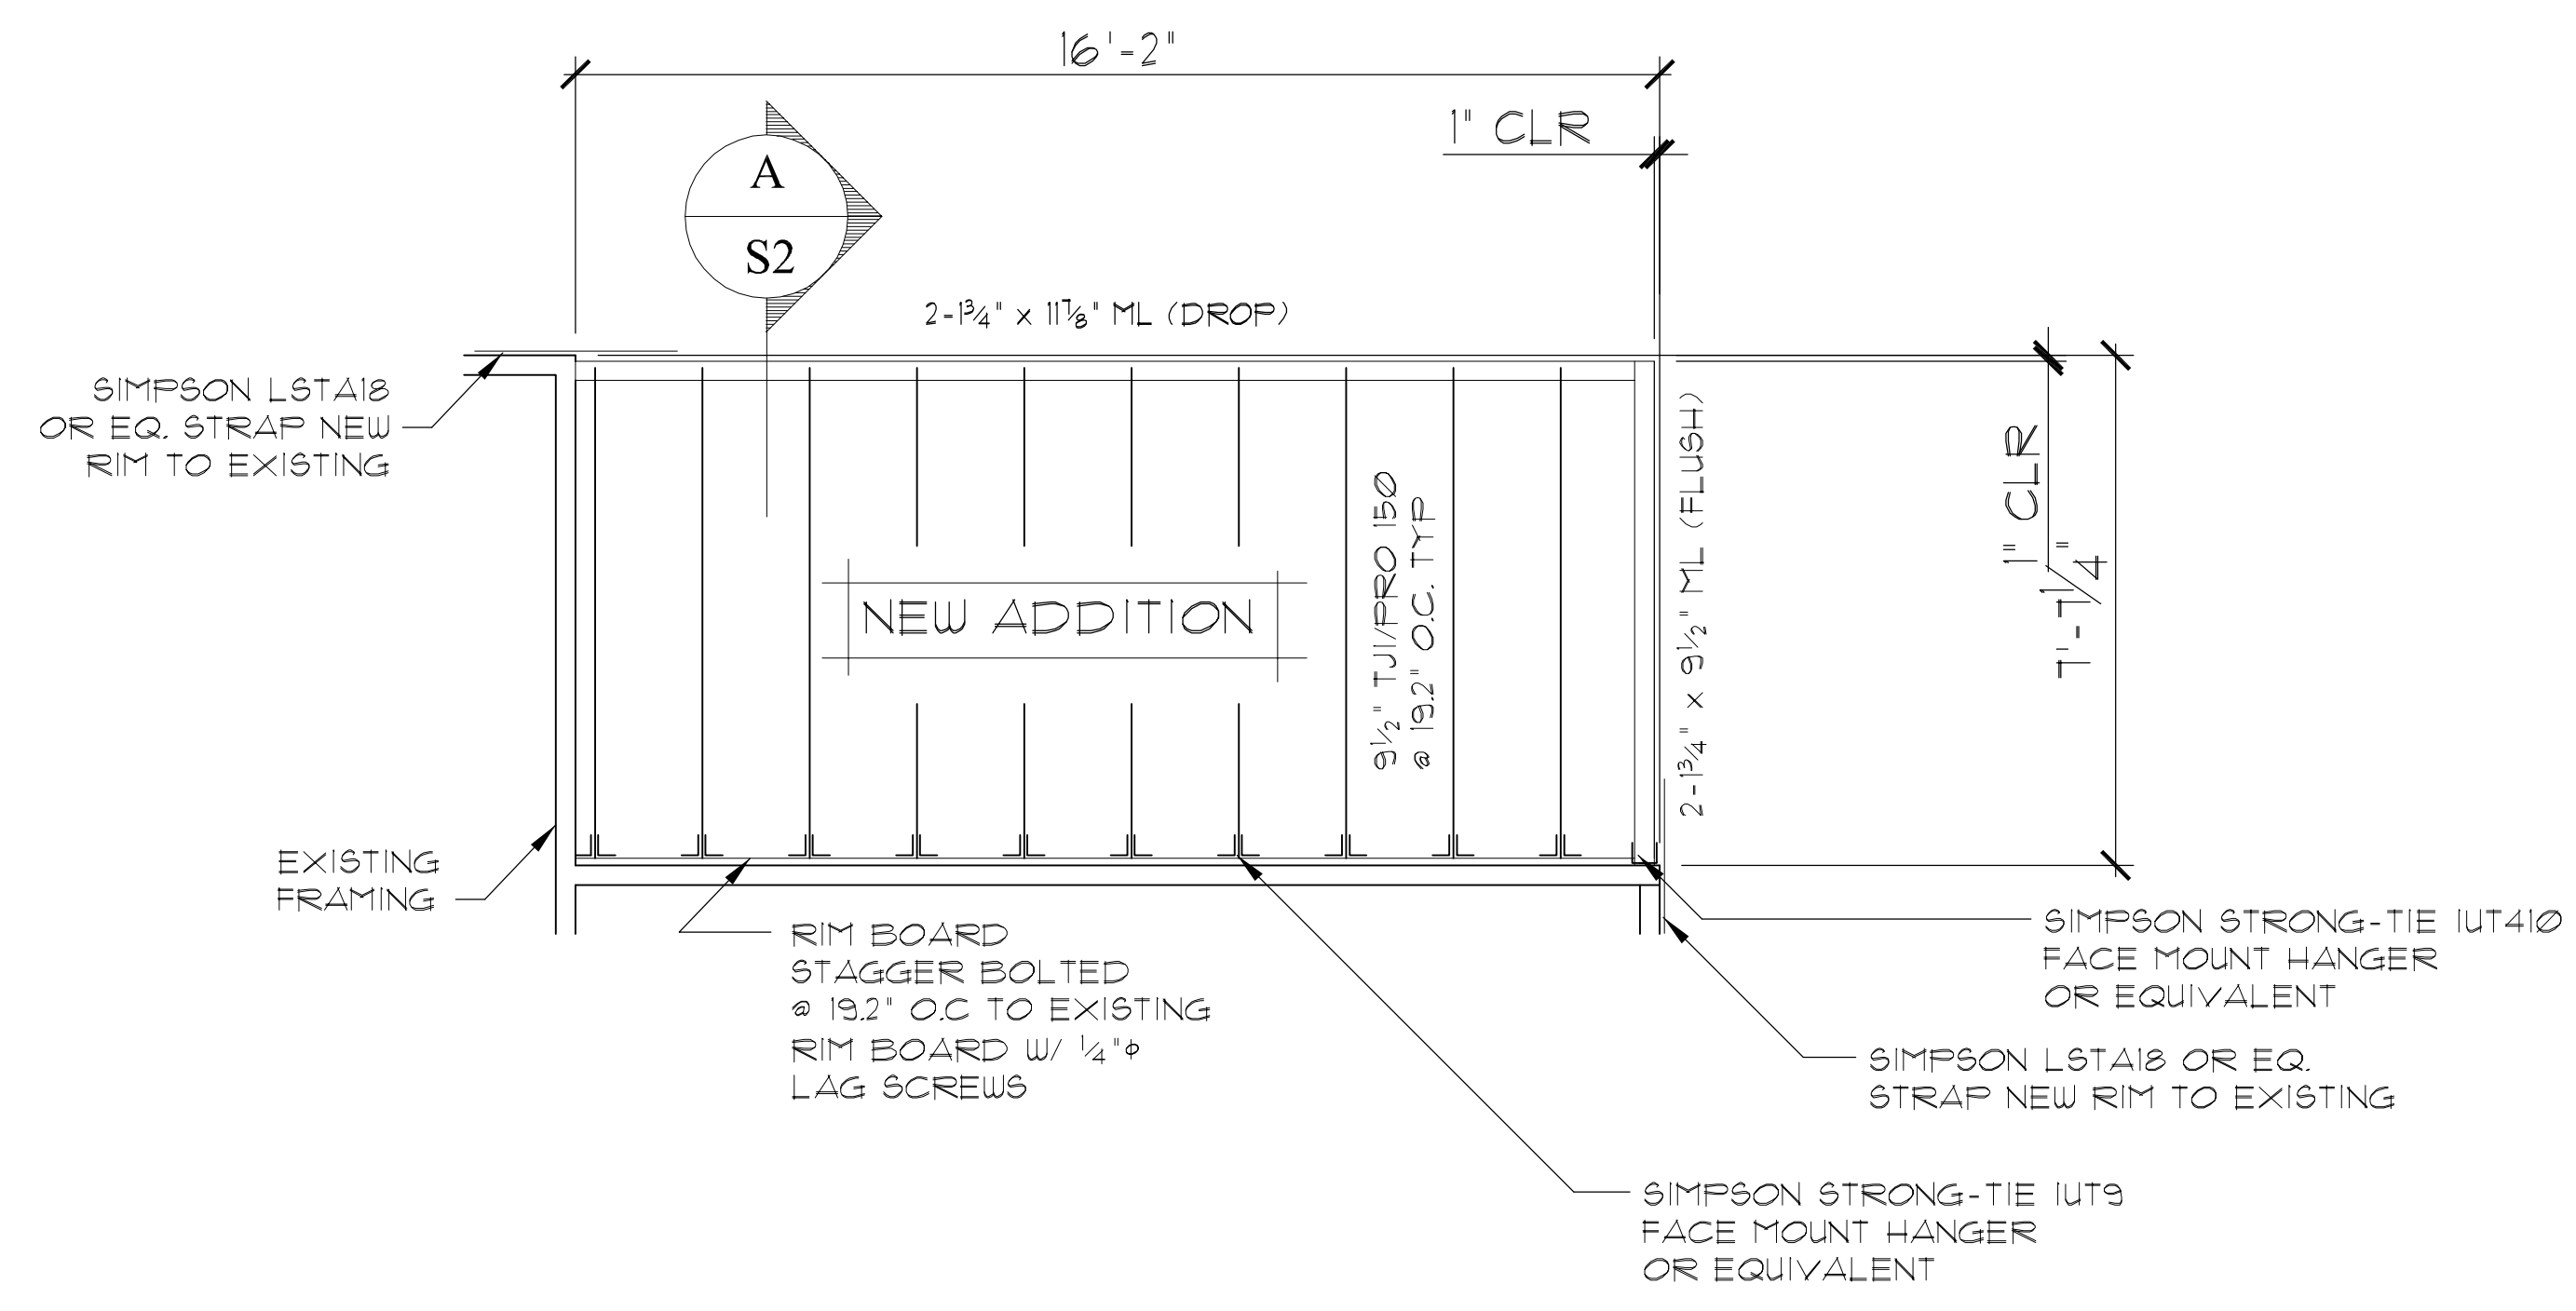

FLOOR FRAMING PLAN
SCALE 1/4" = 1'-0"

HELIX FOUNDATION SCHEDULE					
SYMBOL	QUANTITY	DESIGN CAPACITY	MIN. LENGTH*	PIER CAP CONNECTION	NOTES
①	3	6 KIPS	15' (FT)	MP1920 4X4 WOOD POST CAP	MIN. Ø250 WALL HELIX SHAFT (STD. DUTY)

* MIN. DISTANCE BETWEEN GROUND SURFACE AND UPPERMOST HELICAL BEARING PLATE

HELICAL PILE LAYOUT

NO.	DATE	REVISION/ISSUE

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DESIGNED BY: MMB DATE: 5/26/09
DRAWN BY: MMB SCALE: AS SHOWN
CHECKED BY: HAP
PROJECT NO: RMB19

